ABBREVIATIONS MECHANICAL **ABOVE FINISHED FLOOR** MANUFACTURER MFTR **ALTERNATE** MINIMUM BEARING **NOT TO SCALE BASEMENT** OVERALL ON CENTER CANTILEVER PLFA POINT LOAD FROM ABOVE **CEILING JOIST** PRESSURE TREATED CEILING CLG RISER CMU **CONCRETE MASONRY UNIT** REF REFRIGERATOR CO **CASED OPENING** ROOFING COL COLUMN **ROUGH OPENING** CONC CONCRETE **CONTINUOUS ROOF SUPPORT** CONT **CLOTHES DRYER** STUD COLUMN **SQUARE FOOT (FEET) DOUBLE** SHELF / SHELVES DIAM DIAMETER SHTG SHEATHING DOUBLE JOIST SHW SHOWER DOWN DEEP SIMILAR SINGLE JOIST DR **DOUBLE RAFTER** EXAMPLE ELEVATION STUD POCKET DOUBLE STUD POCKET SPEC'D SPECIFIED EΑ EACH SQUARE **EACH END** EE SCALE: 1/8" = 1'-0" EQ **EQUAL** TREAD TEMPERED GLASS **EXTERIOR** THK THICK(NESS) **FORCED-AIR UNIT TRIPLE JOIST** FDN **FOUNDATION GOLD PACKAGE FEATURES** TOC TOP OF CURB / CONCRETE FINISHED FLOOF FLR FLOOR(ING) TR TRIPLE RAFTER TYPICAL TYP **FIREPLACE** 1. FLUE OR CHIMNEY BY OWNER **UNLESS NOTED OTHERWISE** FTG FOOTING

NOTE: ALL CHAPTERS, SECTIONS, TABLES, AND FIGURES CITED WITHOUT A PUBLICATION TITLE ARE FROM THE APPLICABLE BUILDING

GENERAL

CODE (SEE TITLE SHEET).

HGR

KS

MAX

HOSE BIBB

HEADER

HANGER

MAXIMUM

JACK STUD COLUMN

KING STUD COLUMN

LAMINATED VENEER LUMBER

ELOG HOMES DOES NOT PERFORM GENERAL CONTRACTING SERVICES, IT IS THE OWNER'S RESPONSIBILITY WHEN ACTING AS OWN GENERAL CONTRACTOR TO VERIFY ALL DIMENSIONS PRIOR TO CONSTRUCTION. FURTHER MORE, THE OWNER IS ULTIMATELY RESPONSIBLE FOR CONSTRUCTION MEANS, METHODS, AND SAFETY ON SITE. NOTIFY ELOG HOMES IMMEDIATELY IF DISCREPANCIES ON PLAN EXIST.

ΧJ

CLOTHES WASHER

WELDED WIRE FABRIC

WATER HEATER

EXTRA JOIST

- ALL INTERIOR DOORS, FIXTURES, CABINETS, WALL AND FLOOR FINISHES ARE BY ALL INTERIOR DOORS ARE FRAMED BY ELOG HOMES TO BE 6'-8" TALL UNLESS
- ALL INTERIOR DIMENSIONS ARE FROM STUD FACE TO STUD FACE.
- ALL POSTS ARE DIMENSIONED TO CENTERLINE UNLESS NOTED OTHERWISE INTERIOR ROUND RAILINGS SHOWING IN THE BASEPLAN ARE SUPPLIED BY ELOG HOMES - INSTALLED BY OWNER. ANY ADDITIONAL RAILING OR WALLS, INCLUDING SURROUNDING OR AT THE BASEMENT STAIR. IS BY OWNER - UNLESS A PURCHASE AMENDMENT HAS BEEN ISSUED FROM ELOG HOMES.
- ALL EXTERIOR PORCH AND DECK STAIRS INCLUDING STRINGERS, TREADS, RISERS, AND STAIR RAILINGS ARE TO BE SUPPLIED BY OWNER, U.O.N.
- DECK AND PORCH FRAMING, FLOORING, AND RAILINGS ARE SUPPLIED BY ELOG
- MAIN HOUSE, DECK, AND PORCH FOUNDATIONS INCLUDING ANCHOR BOLTS ARE
- 10. ELEVATIONS DEPICTING GRADING ARE ILLUSTRATIVE ONLY AND DO NOT SHOW 11. ALL TRAPEZOIDAL FIXED GLASS GABLE WINDOWS ABOVE FIRST FLOOR AT
- GABLE ENDS ARE TO BE SUPPLIED BY OWNER. UNLESS OTHERWISE NOTED. 12. ALL TRAPEZOIDAL FIXED GLASS GABLE WINDOWS SHOULD NEVER BE ORDERED
- PRIOR TO OPENINGS BEING FRAMED. 13. ALL BASEMENT LEVEL WINDOWS, DOORS, INTERIOR WALL FRAMING, AND SUPPORT POSTS ARE BY OWNER UNLESS NOTED OTHERWISE.
- 14. CONTINUOUS RIDGE VENTS TO BE SUPPLIED BY OWNER. 15. HEATED AREA IS CALCULATED FROM THE OUTSIDE EDGE OF THE LOG WALL
- 16. INSTALLATION OF DECORATIVE LOG RAFTERS, LOG COLLAR TIES, LOG RIDGES SHOULD BE COORDINATED BY OWNER'S G.C. ELOG HOMES SUPPLIES BUT DOES
- NOT INSTALL THESE ITEMS. 17. DECK FLASHING BY OWNER AND SHOULD BE COORDINATED WITH LOCAL
- MUNICIPALITY'S REQUIREMENTS.
- 18. ALL FINISH ROOF MATERIALS EXCEPT SYNTHETIC UNDERLAYMENT TO BE SUPPLIED BY OWNER. SYNTHETIC UNDERLAYMENT SUPPLIED BY ELOG HOMES. 19. FIREPLACE, CHIMNEY FRAMING, AND FLUE BY OWNER.
- 20. ALL FASCIA TO BE 7/4 X 8 EASTERN WHITE PINE. GABLE ENDS ALSO RECEIVE 2X6 SUB-FASCIA.
- 21. ALL SECOND FLOOR WALLS AND GABLE ENDS RECEIVE MATCHING PROFILE LOG SIDING UNLESS NOTED OTHERWISE.
- 22. (2) COURSES OF LOG SIDING TO BE USED AS SKIRTING ON ALL FOUNDATIONS **EXCEPT ON SLABS... 1X4 P.T. SKIRTING PROVIDED FOR SLABS.**
- 23. IF LOCAL SNOW LOADS REQUIRE SPECIAL STRUCTURAL MEMBERS (PSL COLUMNS OR STEEL POSTS) TO SUPPORT ROOF RIDGE MEMBERS, THEN THOSE ARE TO BE SUPPLIED BY OWNER, U.N.O.
- 24. ROOF AND FLOOR FRAMING PLANS ARE FOR GENERAL INFORMATION ONLY. THE TRUSS MANUFACTURER SHALL PROVIDE A DETAILED LAYOUT FOR TRUSS AND FRAMING MEMBERS.
- 25. SHOULD CONDITIONS AT THE SITE BE FOUND TO BE MATERIALLY DIFFERENT FROM THOSE INDICATED IN THE DRAWINGS AND/OR SPECIFICATIONS, OR CONDITIONS OF AN UNUSUAL NATURE ARE DISCLOSED MATERIALLY DIFFERENT FROM THE CONDITIONS USUALLY INHERENT IN THE WORK OF THE CHARACTER SHOWN AND SPECIFIED; CALL IMMEDIATE ATTENTION TO SUCH CONDITIONS BEFORE THEY ARE DISTURBED.
- 26. DO NOT SCALE DRAWINGS. USE PRINTED DIMENSIONS ONLY. 27. ALL BASEMENT MATERIALS ARE BY OWNER UNLESS A SIGNED AMENDMENT CALLING FOR SPECIFIC MATERIALS TO BE PROVIDED BY ELOG HOMES HAS BEEN
- RECEIVED BY ELOG HOMES. 28. FLORIDA HOUSE MUST USE: ANDERSON WINDOWS/DOORS FL CODE #12496-R5
- ALL WOOD CONNECTORS ARE FL CODE #38731.1 EXCEPT FOR THE FOLLOWING: 1-1/4" ROOFING NAILS FL CODE #38089, ALL JOIST HANGERS FL CODE #13872. 29. STAIRS IN PLANS DEPICT CONSTRUCTION STAIR ONLY.
- 30. BASEMENT WINDOWS TO BE PRICED FOR OWNER TO APPROVE. 31. PLANS, ELEVATIONS, ROOF PLANS REPRESENT THE PRELIMINARY
- ARCHITECTURAL DESIGN.
- 32. ANY ADDITIONS BEYOND THE BASE MODEL ARE TO BE BY OWNER UNLESS NOTED OTHERWISE AND ACCOMPANIED BY A SIGNED AMENDMENT TO THE ORIGINAL

- 2. CONTINUOUS RIDGE VENT BY OWNER
- 3. 7/4X8 FASCIA W/ 2X6 SUB-FASCIA 4. SHINGLES OR METAL ROOF BY OWNER
- CONVENTIONALLY FRAMED 2X WALL W/ LOG SIDING AT GABLES, DORMERS, SECOND STORY WALLS, AND GARAGES.
- 6. 7/4X8 FASCIA ON EAVES
- 7. FALSE LOG CORNERS 8. 8"-12" ROUND HANDCRAFTED POST
- 9. 8X8 CARRY BEAM
- 10. LOG WALL (13 COURSES FOR 8" HIGH LOGS OR 9 COURSES FOR 12"
- HIGH LOGS), SEE ELEVATIONS FOR EXACT COUNT. 11. (2) COURSES OF MATCHING LOG SIDING FOR SKIRTING CRAWLSPACE FOUNDATIONS. 1X4 PRESSURE TREATED TRIM FOR SKIRTING SLAB
- FOUNDATIONS. 12. FIXED GLASS BY OWNER AND WINDOWS UNITS ARE BY ELOG HOMES
- 13. DOOR STYLES AND SIZES VARY PER MODEL (SEE WINDOW AND DOOR
- 14. WINDOW STYLES AND SIZES VARY PER MODEL (SEE WINDOW AND DOOR SCHEDULE)
- 15. GABLE OVERHANGS ARE 24"
- 16. EAVE OVERHANG WILL BE 12"-16"
- 17. DECK, FRAMING, FLOORING AND RAILING BY ELOG HOMES 18. ALL STAIRS & STAIRS MATERIALS TO GRADE BY OWNER

SILVER PACKAGE FEATURES

- FLUE OR CHIMNEY BY OWNER
- 2. CONTINUOUS RIDGE VENT BY OWNER
- 3. 7/4X8 FASCIA W/ 2X6 SUB-FASCIA SHINGLES OR METAL ROOF BY OWNER
- 5. CONVENTIONALLY FRAMED 2X WALL W/ LOG SIDING AT GABLES, DORMERS, SECOND STORY WALLS, AND GARAGES.
- 6. 7/4X8 FASCIA ON EAVES 7. FALSE LOG CORNERS
- 8. 4"X6" RECTANGULAR POST
- 10. LOG WALL (13 COURSES FOR 8" HIGH LOGS OR 9 COURSES FOR 12"
- HIGH LOGS), SEE ELEVATIONS FOR EXACT COUNT. 11. (2) COURSES OF MATCHING LOG SIDING FOR SKIRTING CRAWLSPACE FOUNDATIONS. 1X4 PRESSURE TREATED TRIM FOR SKIRTING SLAB
- FOUNDATIONS. 12. FIXED GLASS BY OWNER AND WINDOWS UNITS ARE BY ELOG HOMES
- (MODEL DEPENDANT) 13. DOOR STYLES AND SIZES VARY PER MODEL (SEE WINDOW AND DOOR
- SCHEDULE)
- 14. WINDOW STYLES AND SIZES VARY PER MODEL (SEE WINDOW AND DOOR SCHEDULE)
- 15. GABLE OVERHANGS ARE 12"
- 16. EAVE OVERHANG WILL BE 12"-16"
- 17. DECK, FRAMING, FLOORING AND RAILING BY ELOG HOMES 18. ALL STAIRS & STAIRS MATERIALS TO GRADE BY OWNER

PLATINUM PACKAGE FEATURES

- 1. FLUE OR CHIMNEY BY OWNER
- 2. CONTINUOUS RIDGE VENT BY OWNER 3. 7/4X8 FASCIA W/ 2X6 SUB-FASCIA
- 4. SHINGLES OR METAL ROOF BY OWNER 5. CONVENTIONALLY FRAMED 2X WALL W/ LOG SIDING AT GABLES,
- DORMERS, SECOND STORY WALLS, AND GARAGES. 6. 7/4X8 FASCIA ON EAVES
- 7. FALSE LOG CORNERS
- 8. 8"-12" ROUND HANDCRAFTED POST
- 9. 8X8 CARRY BEAM
- 10. LOG WALL (13 COURSES FOR 8" HIGH LOGS OR 9 COURSES FOR 12" HIGH LOGS), SEE ELEVATIONS FOR EXACT COUNT.
- 11. (2) COURSES OF MATCHING LOG SIDING FOR SKIRTING CRAWLSPACE FOUNDATIONS. 12. FIXED GLASS BY OWNER AND WINDOWS UNITS (A SERIES) ARE BY
- **ELOG HOMES (MODEL DEPENDANT)** 13. DOOR STYLES AND SIZES VARY PER MODEL (SEE A SERIES WINDOW
- AND DOOR SCHEDULE) 14. WINDOW STYLES AND SIZES VARY PER MODEL (SEE A SERIES WINDOW AND DOOR SCHEDULE)
- 15. GABLE OVERHANGS ARE 24"
- 16. EAVE OVERHANG WILL BE 12"-16"
- 17. DECK, FRAMING, FLOORING AND RAILING BY ELOG HOMES
- 18. ALL STAIRS & STAIRS MATERIALS TO GRADE BY OWNER
- 19. STRUCTURAL INSULATED PANELS (SIPS) AT SECOND FLOOR: STANDARD 6" ON WALLS AND UPPER GABLE, 8" SIP ON ROOF (USE TRADITIONAL FRAMING ON GARAGE)

FASTENER SCHEDULE			
CONNECTION	3" x 0.131" NAIL	3" x 0.120" NAIL	
JOIST TO SILL PLATE	(4) TOE NAILS	(4) TOE NAILS	
SOLE PLATE TO JOIST / BLOCKING	NAILS @ 8" OC (typical) (4) PER 16" SPACE (at braced panels)	NAILS @ 8" OC (typical) (4) PER 16" SPACE (at braced panels)	
STUD TO SOLE PLATE	(4) TOE NAILS	(4) TOE NAILS	
TOP OR SOLE PLATE TO STUD	(3) FACE NAILS	(4) FACE NAILS	
RIM JOIST OR BAND JOIST TO TOP PLATE OR SILL PLATE	TOE NAILS @ 6" OC	TOE NAILS @ 4" OC	
BLOCKING BETWEEN JOISTS TO TOP PLATE OR SILL PLATE	(4) TOE NAILS	(4) TOE NAILS	
DOUBLE STUD	NAILS @ 8" OC	NAILS @ 8" OC	
DOUBLE TOP PLATES	NAILS @ 12" OC	NAILS @ 12" OC	
DOUBLE TOP PLATES LAP (24" MIN LAP LENGTH)	(12) NAILS IN LAPPED AREA, EA SIDE OF JOINT	(12) NAILS IN LAPPED AREA, EA SIDE OF JOINT	
TOP PLATE LAP AT CORNERS AND INTERSECTING WALLS	(3) FACE NAILS	(3) FACE NAILS	
OPEN-WEB TRUSS BOTTOM CHORD TO TOP PLATES OR SILL PLATE (PARALLEL TO WALL)	NAILS @ 6" OC	NAILS @ 4" OC	
BOTTOM CHORD OF TRUSS TO TOP PLATES OR SILL PLATE (PERPENDICULAR TO WALL)	(3) TOE NAILS	(3) TOE NAILS	

DETAILS AND NOTES ON DRAWINGS GOVERN.

STRUCTURAL WOOD

- ALL BEARING HEADERS TO BE (2) 2x6 SUPPORTED W/ MIN (1) JACK STUD AND (1) KING STUD EACH END FOR 2X4 FRAMED EXTERIOR WALLS. ALL BEARING HEADERS TO BE (3) 2x6 W/ OSB SPACER FOR 2X6
- FRAMED EXTERIOR WALLS, UNO. ALL NON-BEARING HEADERS W/IN 2X4 FRAMED WALLS TO BE (2) 2x4, UNO.
- NON-BEARING INTERIOR WALLS NOT MORE THAN 10' NOMINAL HEIGHT AND NOT SHOWN AS BRACED
- WALLS MAY BE FRAMED WITH 2x4 STUDS @ 24" OC. SOLID BLOCKING TO BE PROVIDED AT ALL POINT LOADS THROUGH FLOOR LEVELS TO THE FOUNDATION
- OR TO OTHER STRUCTURAL COMPONENTS. 5. ALL BEAMS SPECIFIED ARE MINIMUM SIZES ONLY. LARGER MEMBERS MAY SUBSTITUTED AS NEEDED
- ALL BEAMS TO BE CONTINUOUSLY SUPPORTED LATERALLY AND SHALL BEAR FULL WIDTH ON THE SUPPORTING WALLS OR COLUMNS INDICATED, WITH A MINIMUM OF THREE STUDS, UNO.
- WHEN A 4-PLY LVL BEAM IS USED, ATTACH WITH (1) 1/2" DIAMETER BOLT, 12" OC, STAGGERED TOP AND BOTTOM, 1 1/2" MIN FROM ENDS. ALTERNATE EQUIVALENT ATTACHMENT METHOD MAY BE USED, SUCH
- AS SDS, SDW, OR TRUSSLOK SCREWS (SEE MANUFACTURER SPECIFICATIONS). FOR STUD COLUMNS OF 4-OR-MORE STUDS, INSTALL SIMPSON STRONG-TIE CS16 STRAPS ACROSS STUDS @ 30" OC, 6" MAX FROM PLATES, ON INSIDE FACE OF COLUMN (EXTERIOR WALL), ON BOTH **FACES OF COLUMN (INTERIOR WALL).**
- 9. FLOOR JOISTS ADJACENT AND PARALLEL TO THE EXTERIOR FOUNDATION WALL SHALL BE PROVIDED WITH FULL-DEPTH SOLID BLOCKING, NOT LESS THAN TWO (2) INCHES NOMINAL IN THICKNESS, PLACED PERPENDICULAR TO THE JOIST AT SPACING NOT MORE THAN FOUR (4) FEET. THE BLOCKING SHALL BE NAILED TO THE FLOOR SHEATHING, THE SILL PLATE, THE JOIST, AND THE EXTERIOR RIM JOIST / BOARD.

LOG WALL MATERIAL SPECIFICATION

- 1. COMMON NAME(S): EASTERN WHITE PINE
- 2. AVERAGE DRIED WEIGHT: 25 LBS/FT3 (400 KG/M3)
- 3. SPECIFIC GRAVITY (BASIC, 12% MC): .34, .40 4. MODULUS OF RUPTURE: 8,600 LBF/IN2 (59.3 MPA)
- 5. ELASTIC MODULUS: 1,240,000 LBF/IN2 (8.55 GPA) 6. CRUSHING STRENGTH: 4,800 LBF/IN2 (33.1 MPA)

CONSTRUCTION NOTES


- 1. FIELD VERIFY ALL DIMENSIONS AND MATERIALS. ALL OUTSIDE DIMENSIONS ARE TO FACE OF RIM JOIST.
- 2. ALL NAILING CONSTRUCTION MATERIALS SHALL BE AS PER 2021 IRC.
- 3. CONTRACTOR SHALL CALL ATTENTION TO THE OWNER ANY DISCREPANCIES IN DRAWINGS AND / OR SPECIFICATIONS AND SHALL RECEIVE PROPER INSTRUCTIONS BEFORE PROCEEDING WITH THE PORTION OF THE WORK IN QUESTION.
- 4. ROOF AND FLOOR FRAMING PLANS ARE FOR GENERAL INFORMATION ONLY. THE TRUSS MANUFACTURER SHALL PROVIDE A DETAILED LAYOUT FOR TRUSS AND FRAMING MEMBERS.
- 5. SHOULD CONSITIONS AT THE SITE BE FOUND TO BE MATERIALLY DIFFERENT FROM THOSE INDICATED IN THE DRAWINGS AND / OR SPECIFICATIONS. OR CONSTIONS OF AN UNUSUAL NATURE ARE DISCLOSED MATERIALLY DIFFERENT FROM THE CONSITIONS USUALLY INHERENT IN THE WORK OF THE CHARACTER SHOWN AND SPECIFIED: CALL IMMEDIATE ATTENTION TO SUCH CONDITIONS BEFORE THEY ARE DISTURBED.
- 6. DO NOT SCALE DRAWINGS. USE PRINTED DIMENSIONS ONLY. 7. DUE TO THE AVAILABILITY OF MATERIALS, ELOG HOMES RESERVES THE RIGHT TO SUBSTITUTE MATERIAL SHOWN ON PLANS FOR A COMMENSURATE MATERIAL WHICH IS IN COMPLIANCE WITH SAFETY AND BUILDING CODE REQUIREMENTS.
- 8. THESE DETAIL SHEETS CONTAIN INFORMATION WHICH IS IMPERATIVE TO THE PROPER AND TIMELY CONSTRUCTION OF YOUR HOUSE.
- 9. STANDARD MEANS AND METHODS OF CONSTRUCTION SHOULD BE INCORPORATED INTO ALL **WORK WITH SPECIAL ATTENTION GIVEN TO SAFETY.**

DESIGN CRITERIA

TLE BLOCK 1,500 PSF
1,500 PSF
20 PSF
40 PSF
. 30 PSF
20 PSF
20 PSF
1.0
1.0
1.1
115 mp
TBD
II
C
TBD

f. ROOF COMPONENTS AND CLADDING: g. WALL COMPONENTS AND CLADDING:

OGHOMES COM DOES NOT CLAIM ANY RESPONSIBILITY F THE COMPLIANCE OF THESE PLANS TO ANY OF THE ESTABLISHI STATE OR NATIONAL BUILDING CODES. DUE TO THE SPECIFIC COVENANCES MAY IMPOSE FOR YOUR BUILD AREA. IT IS TO RESPONSIBILITY OF THE CUSTOMER TO HAVE THESE PLAI APPROVED BY A LICENSED STRUCTURAL ENGINEER AND LICENSED INSPECTOR. THE WRITTEN DIMENSIONS SHALL HA PRECEDENCE OVER SCALED DIMENSIONS, OWNER TO VERIE ALL DIMENSIONS PRIOR TO CONSTRUCTION. THESE PLANS A THE RIGHT TO USE THESE PLANS FOR ITS OWN PURPOSE.

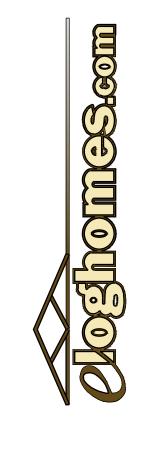

LOG PROFILE

HANDCRAFTED

8/6 CLASSIC D

12/4/2024 DRAWN BY: GM/AM CUST. ID #: 331390751 MODEL NAME: AURORA **DELIVERY MONTH:** DEC 24 PACKAGE: GOLD CODE REF: 2018 IRC


CRAWLSPACE


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FOUNDATION:


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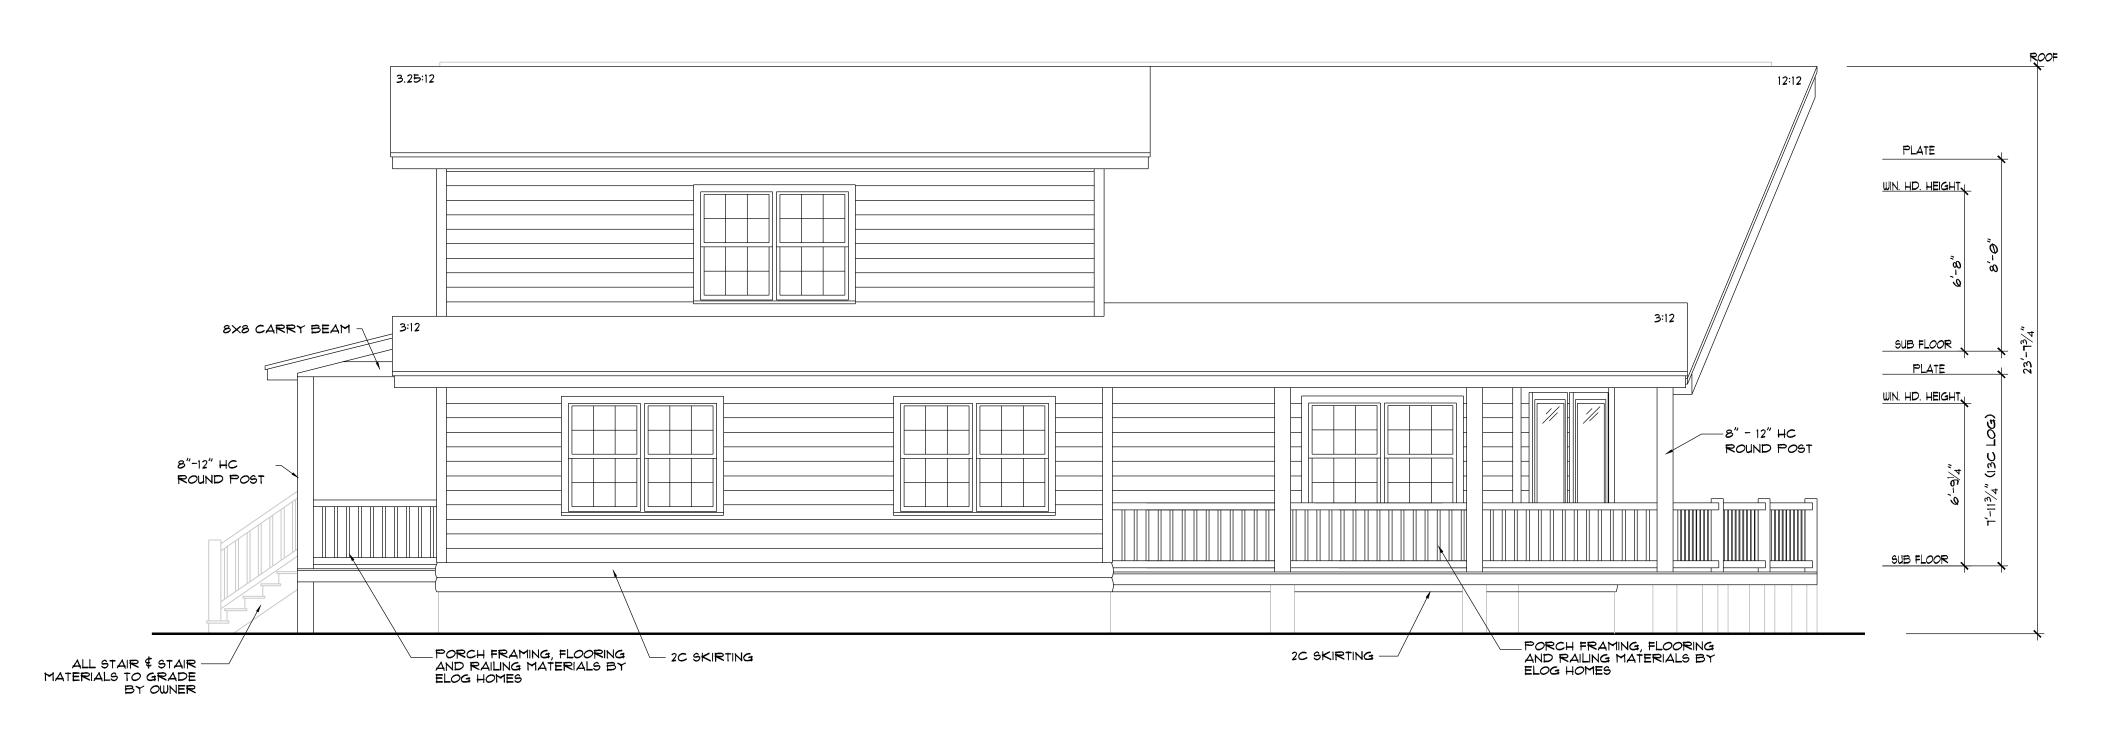
GENERAL NOTES



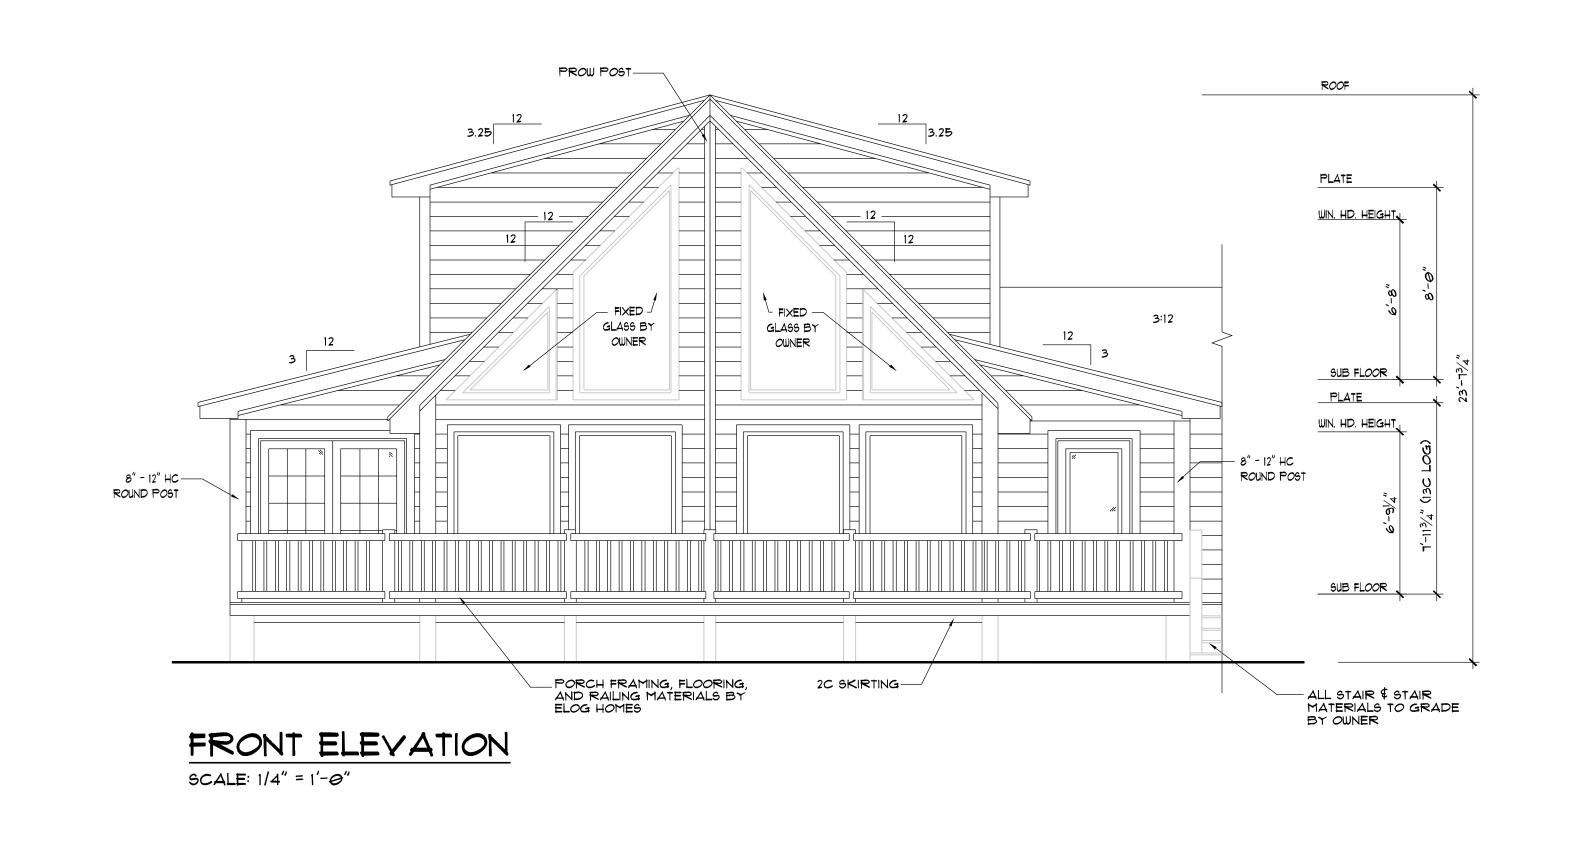

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LEFT ELEVATION

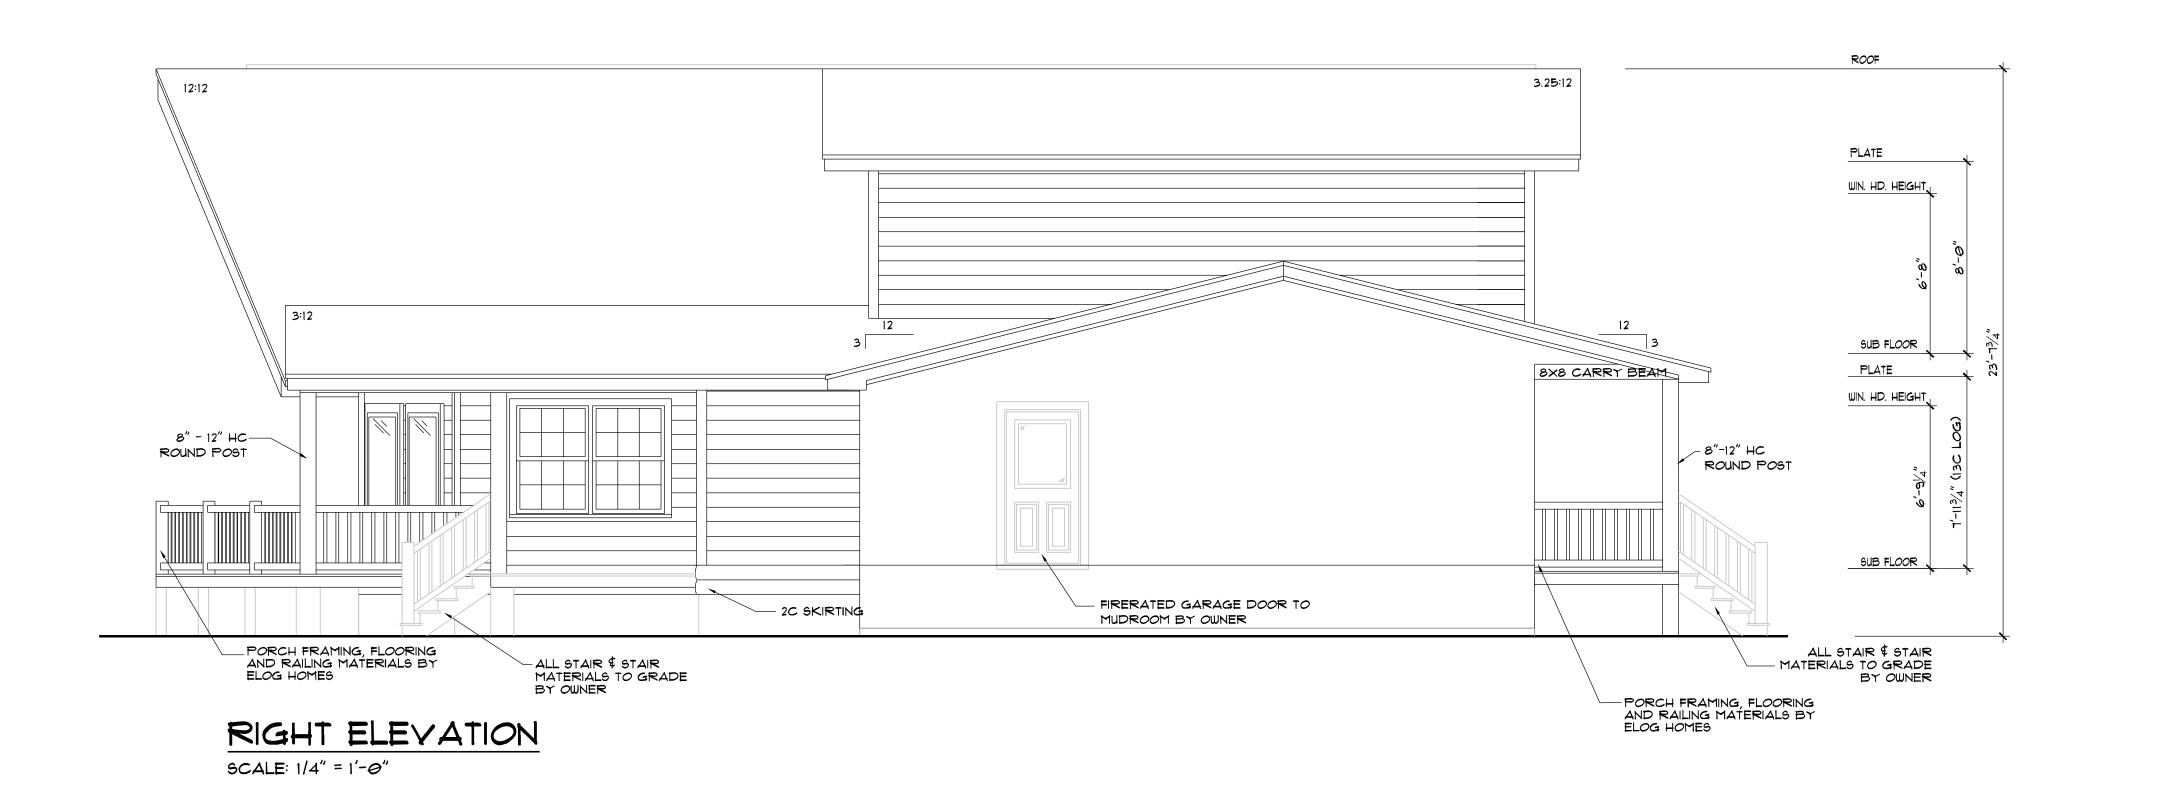SCALE: 1/4" = 1'-0"
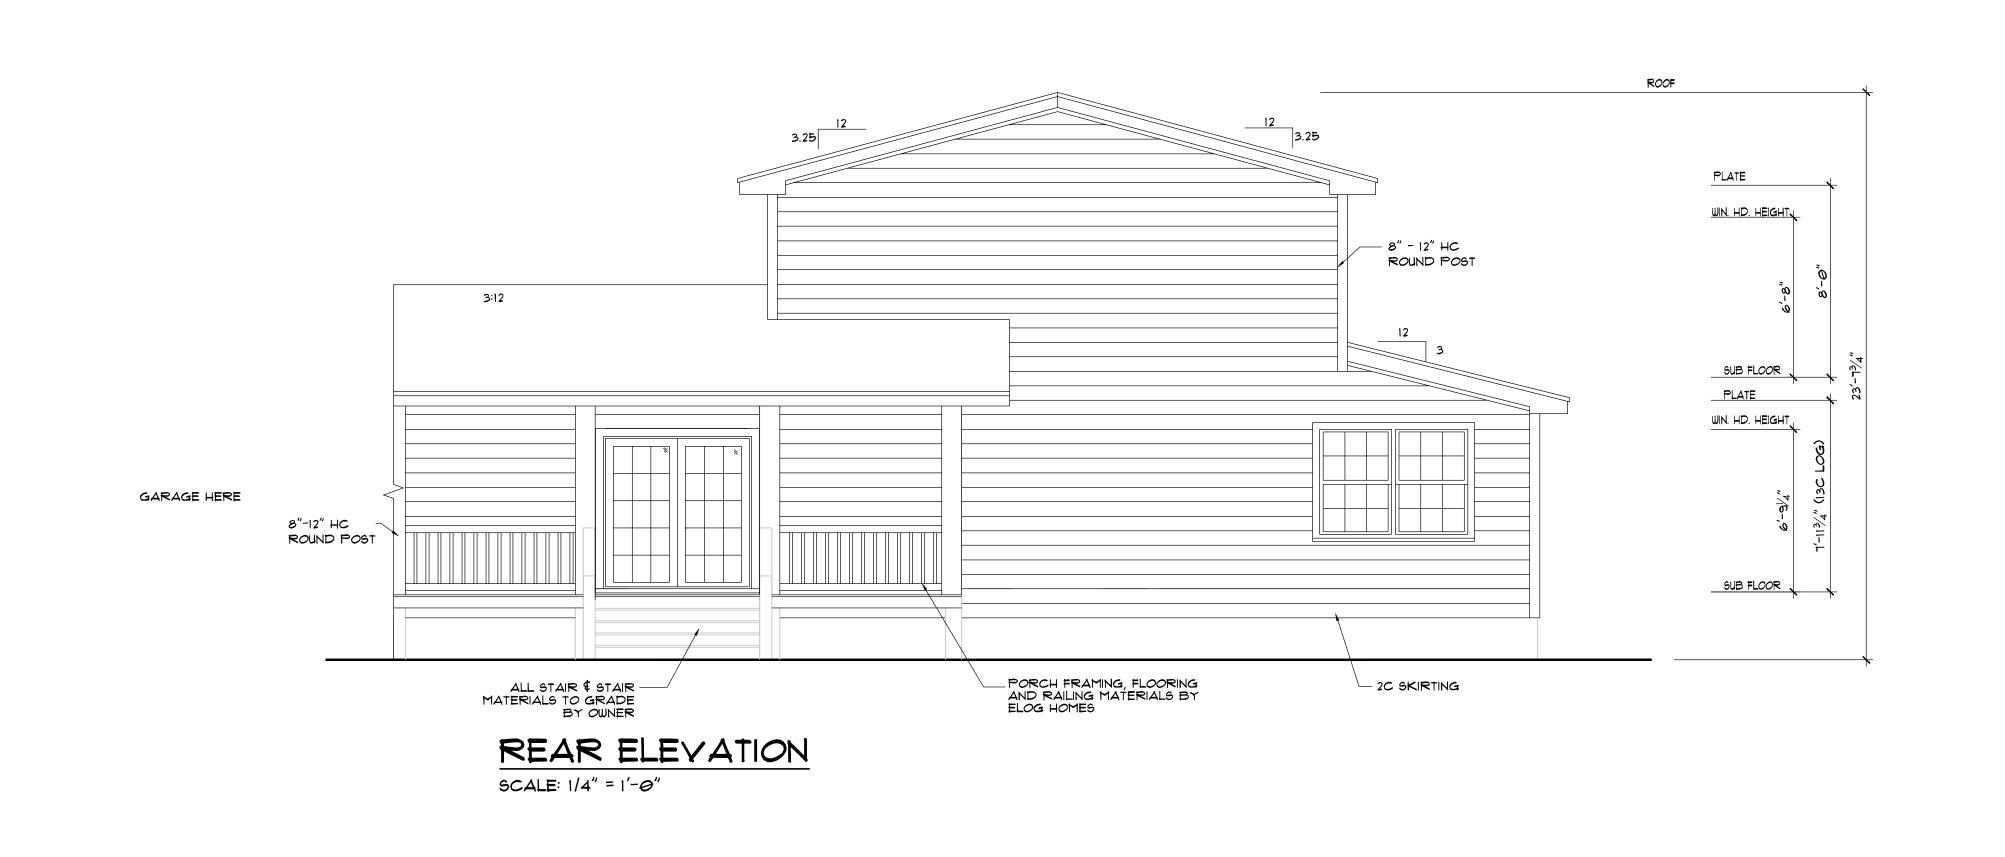
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Noghoinesem

LOG PROFILE

8/6 CLASSIC D

HANDCRAFTED

12/4/2024 GM/AM

AURORA DEC 24 GOLD

331390751


DATE:
DRAWN BY:
CUST. ID #:
MODEL NAME:
DELIVERY MONTH:
PACKAGE:

CODE REF: 2018 IRC FOUNDATION: CRAWLSPACE REVISIONS:

BY

ELEVATIONS

B1.1

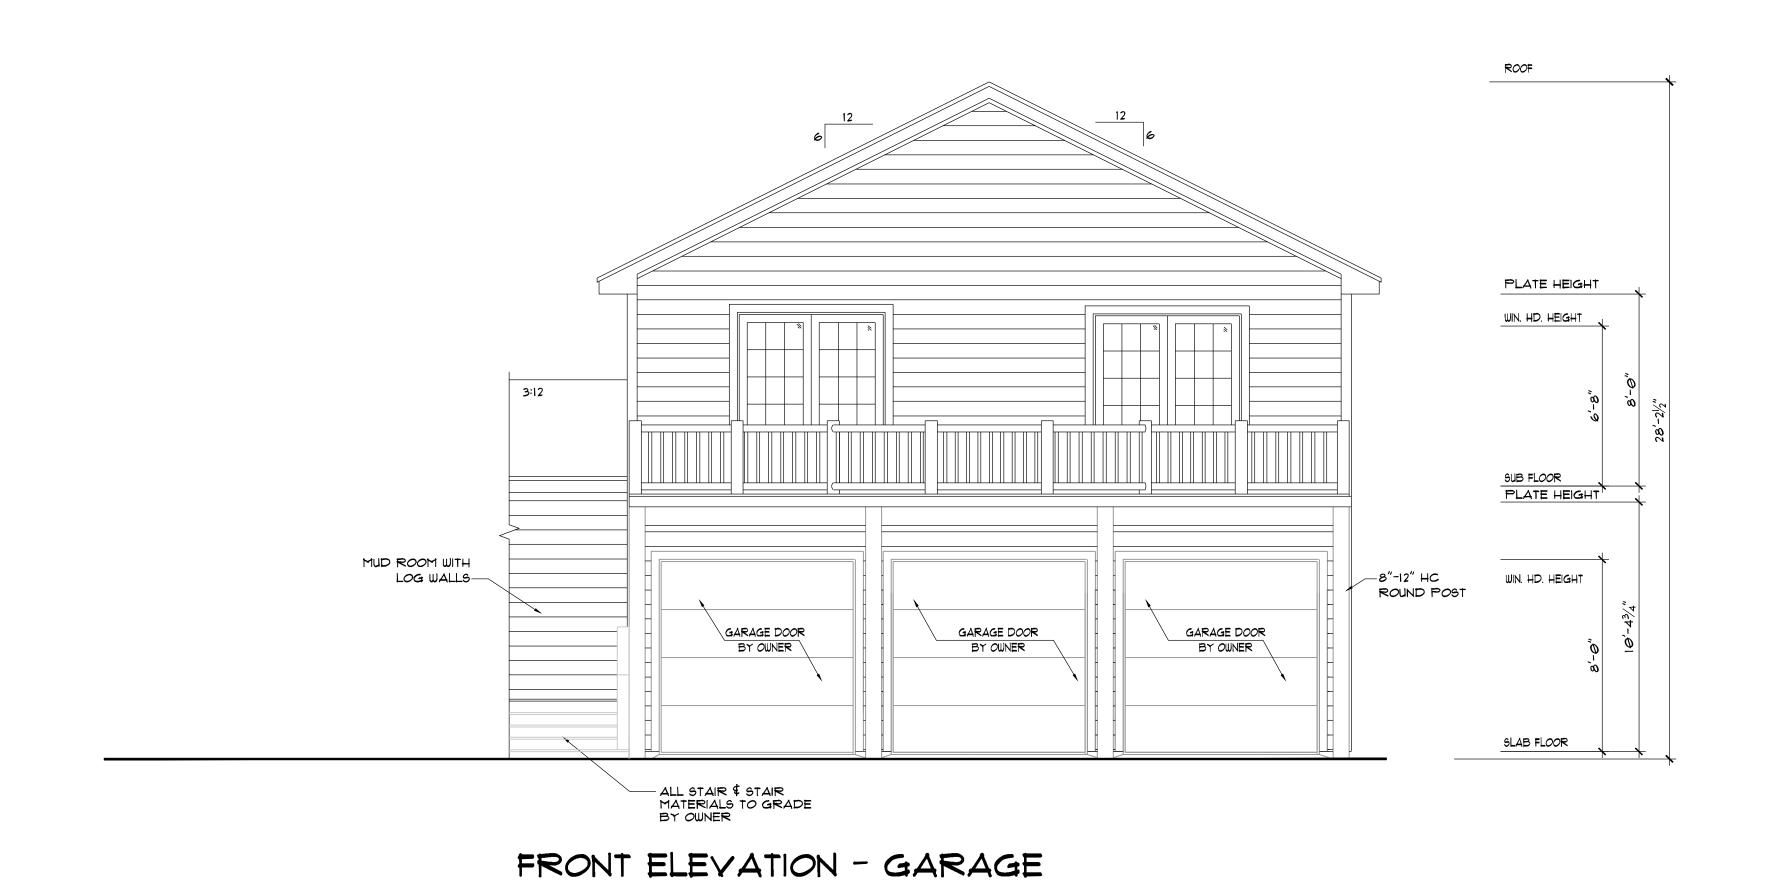

SCALE: 1/4" = 1'-0"





RIGHT ELEVATION - GARAGE

SCALE: 1/4" = 1'-0"

1×4 PT. SKIRT

eLOGHOMES.COM DOES NOT CLAIM ANY RESPONSIBILITY FOR THE COMPLIANCE OF THESE PLANS TO ANY OF THE ESTABLISHED STATE OR NATIONAL BUILDING CODES. DUE TO THE SPECIFIC STATE OR NATIONAL BUILDING CODES. DUE TO THE SPECIFIC REQUIREMENTS THAT THESE CODES OR ANY OTHER COVENANCES MAY IMPOSE FOR YOUR BUILD AREA, IT IS THE RESPONSIBILITY OF THE CUSTOMER TO HAVE THESE PLANS APPROVED BY A LICENSED STRUCTURAL ENGINEER AND A LICENSED INSPECTOR. THE WRITTEN DIMENSIONS SHALL HAVE PRECEDENCE OVER SCALED DIMENSIONS, OWNER TO VERIFY ALL DIMENSIONS PRIOR TO CONSTRUCTION. THESE PLANS ARE THE PROPERTY OF 6LOGHOMES, AND 6LOGHOMES RESERVES THE RIGHT TO USE THESE PLANS FOR ITS OWN PURPOSE. LOG PROFILE 8/6 CLASSIC D HANDCRAFTED 12/4/2024 GM/AM DATE: DRAWN BY: 331390751 AURORA DEC 24 GOLD 2018 IRC CRAWLSPACE CUST. ID #: MODEL NAME: DELIVERY MONTH: PACKAGE: CODE REF: FOUNDATION: REVISIONS: **ELEVATIONS B1.2**

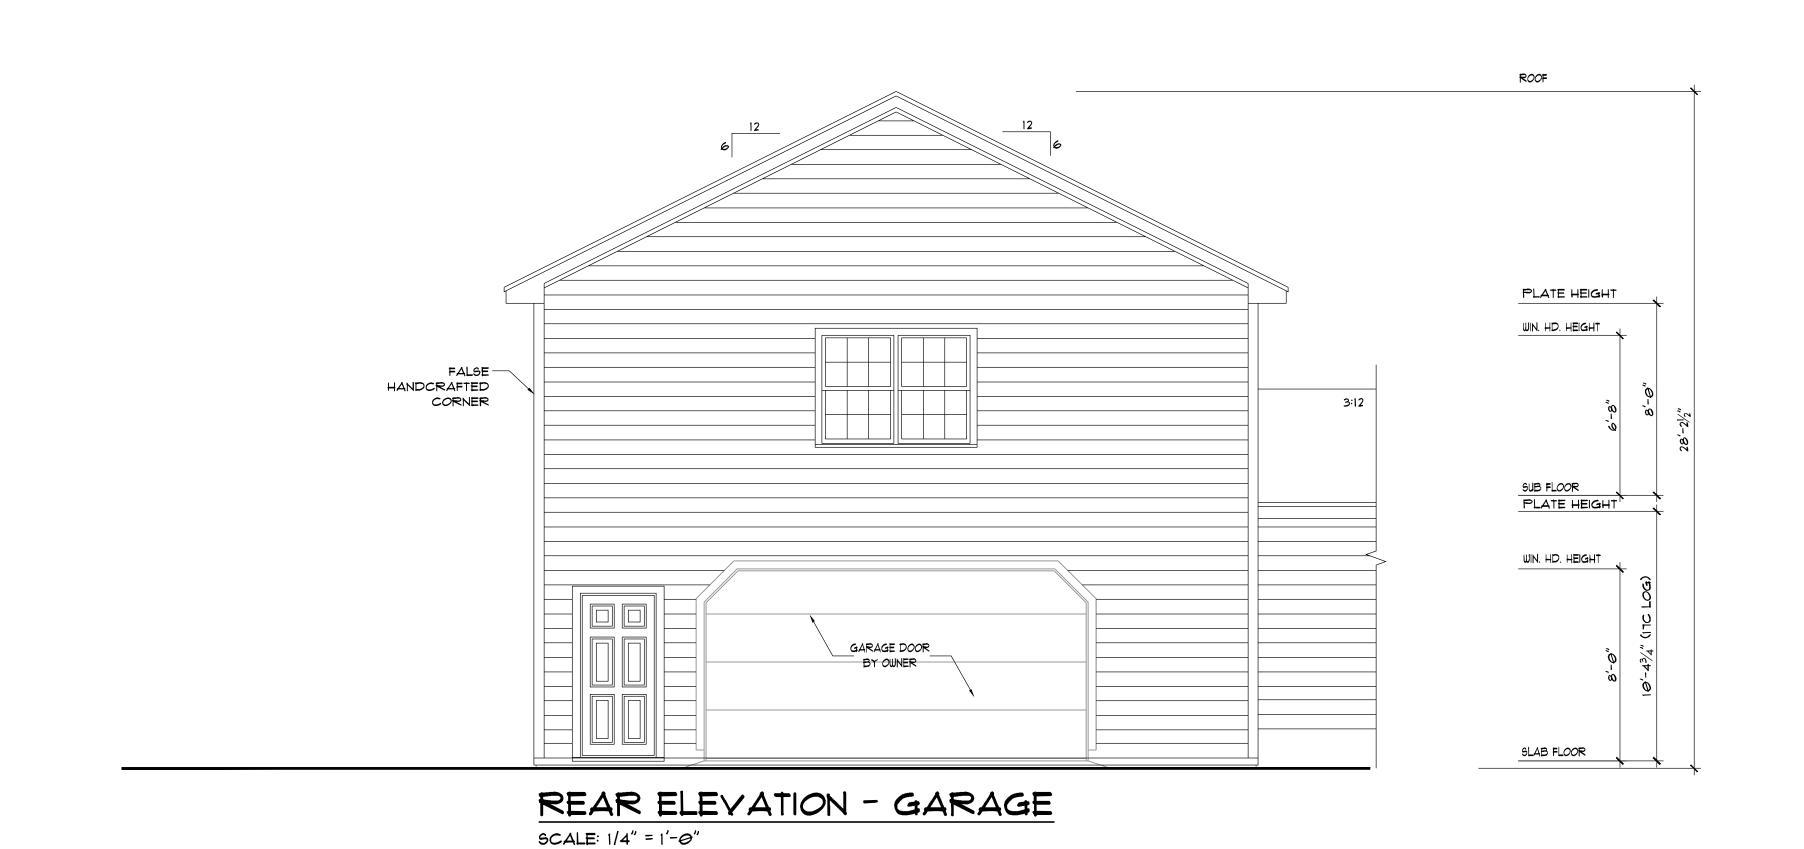

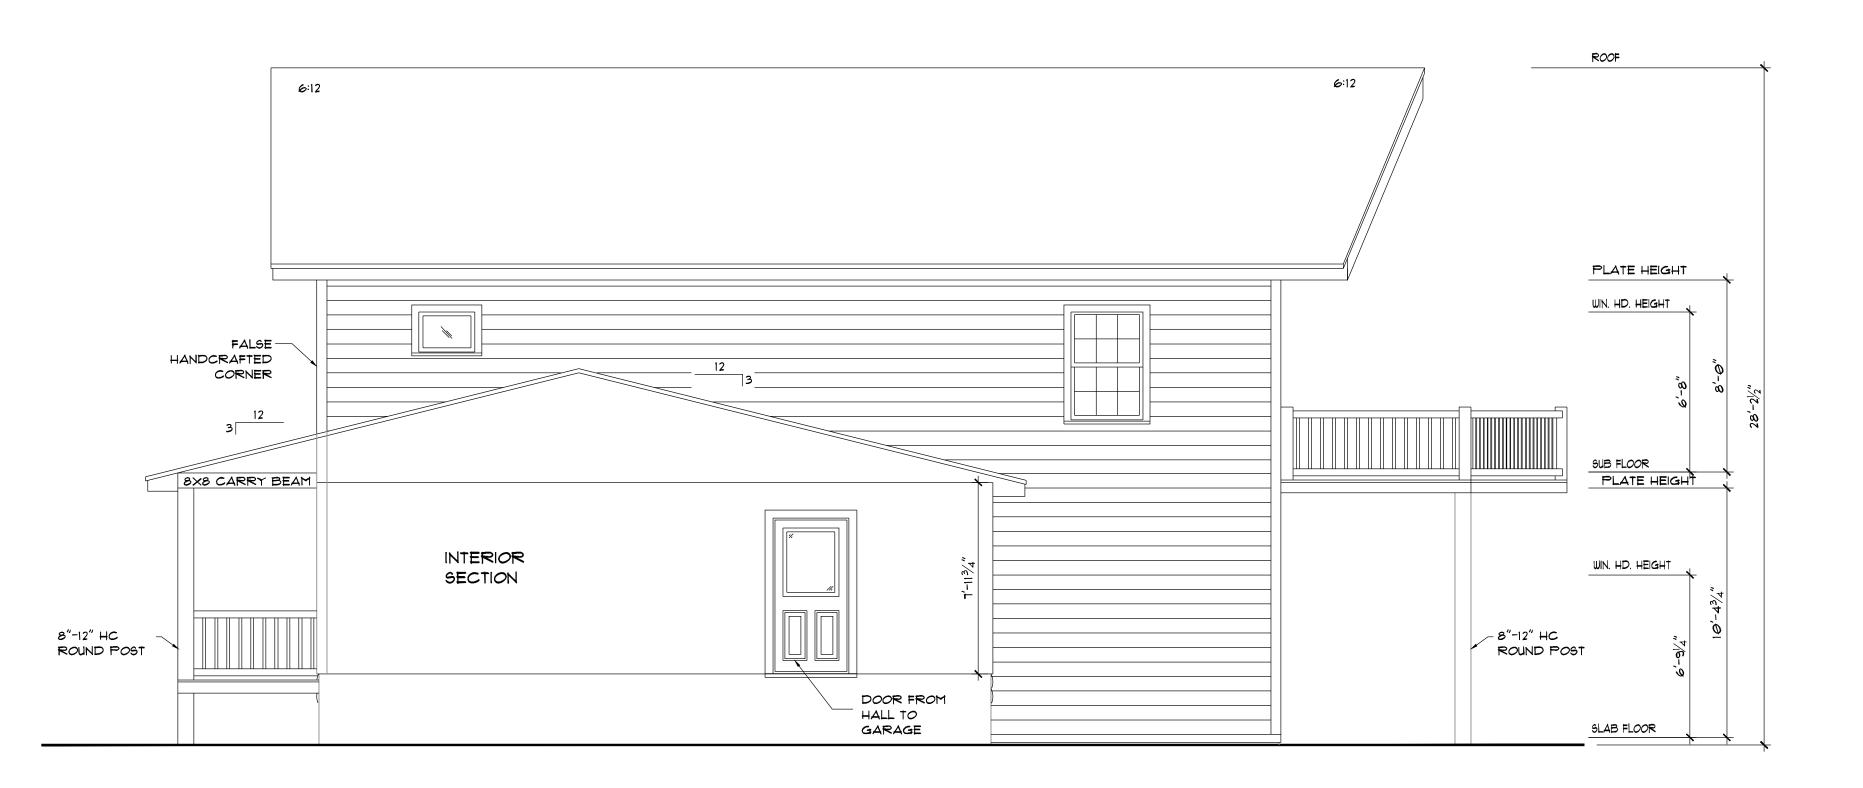

LEFT ELEVATION - GARAGE

SCALE: 1/4" = 1'-0"

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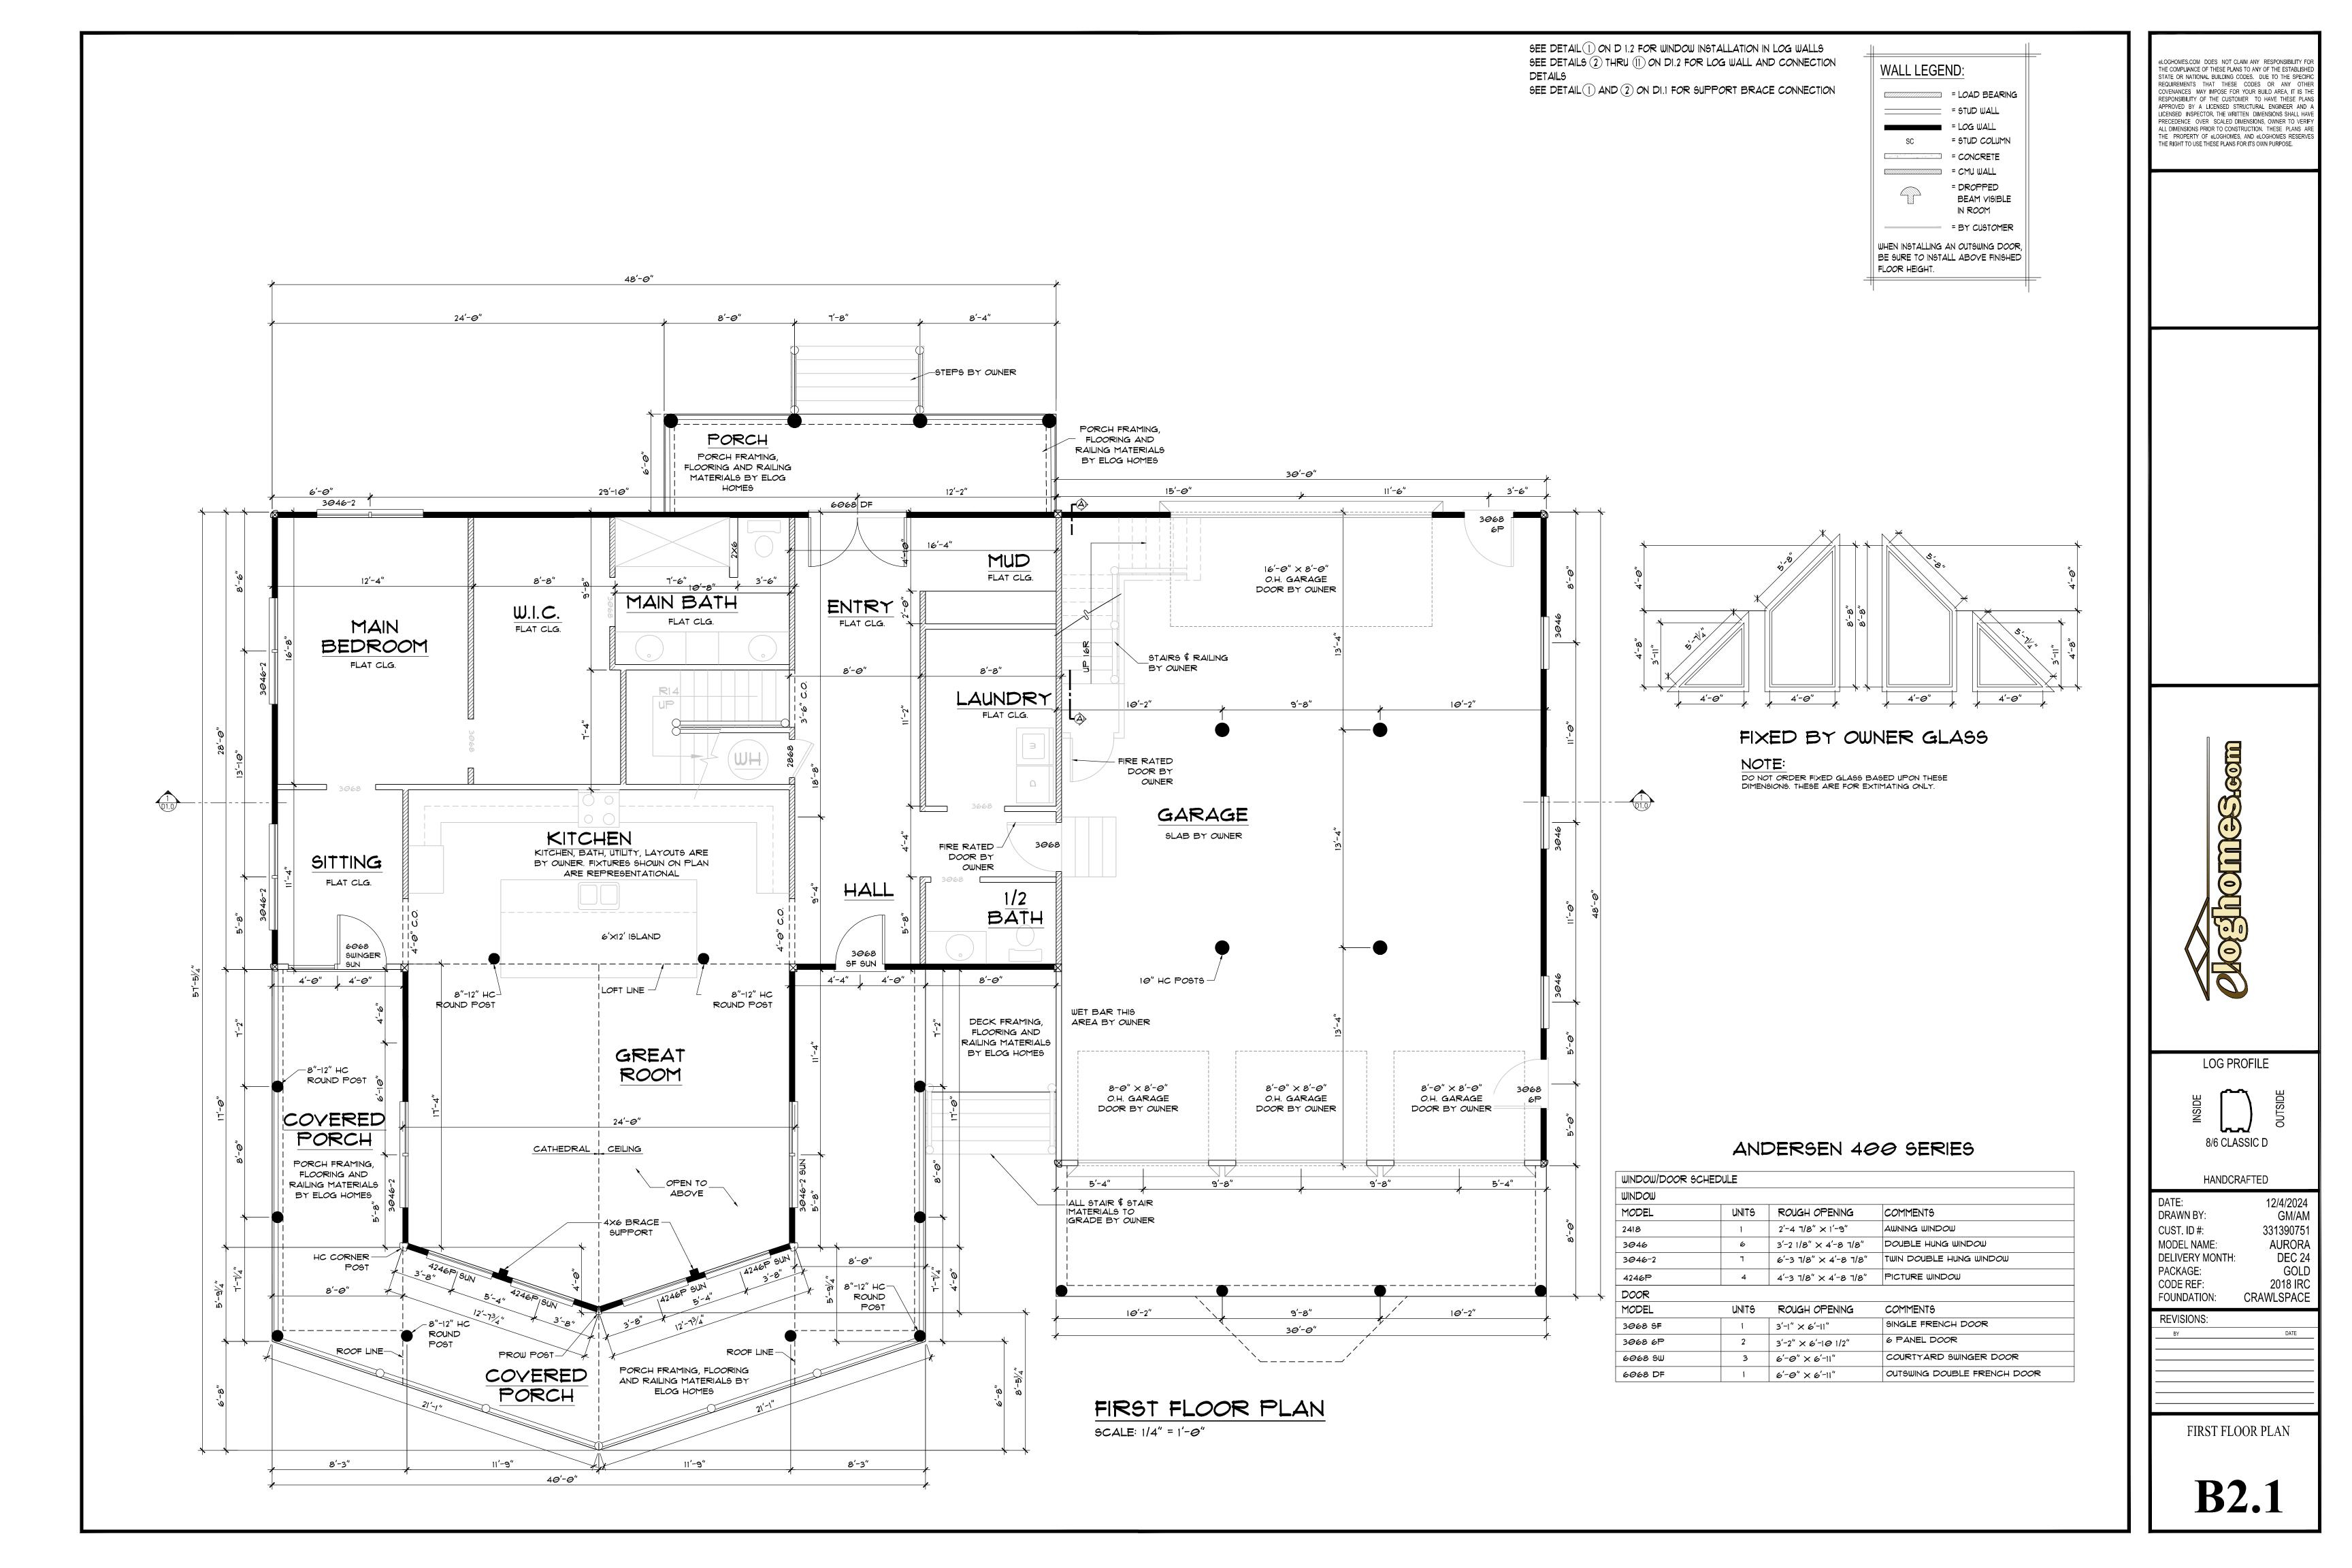
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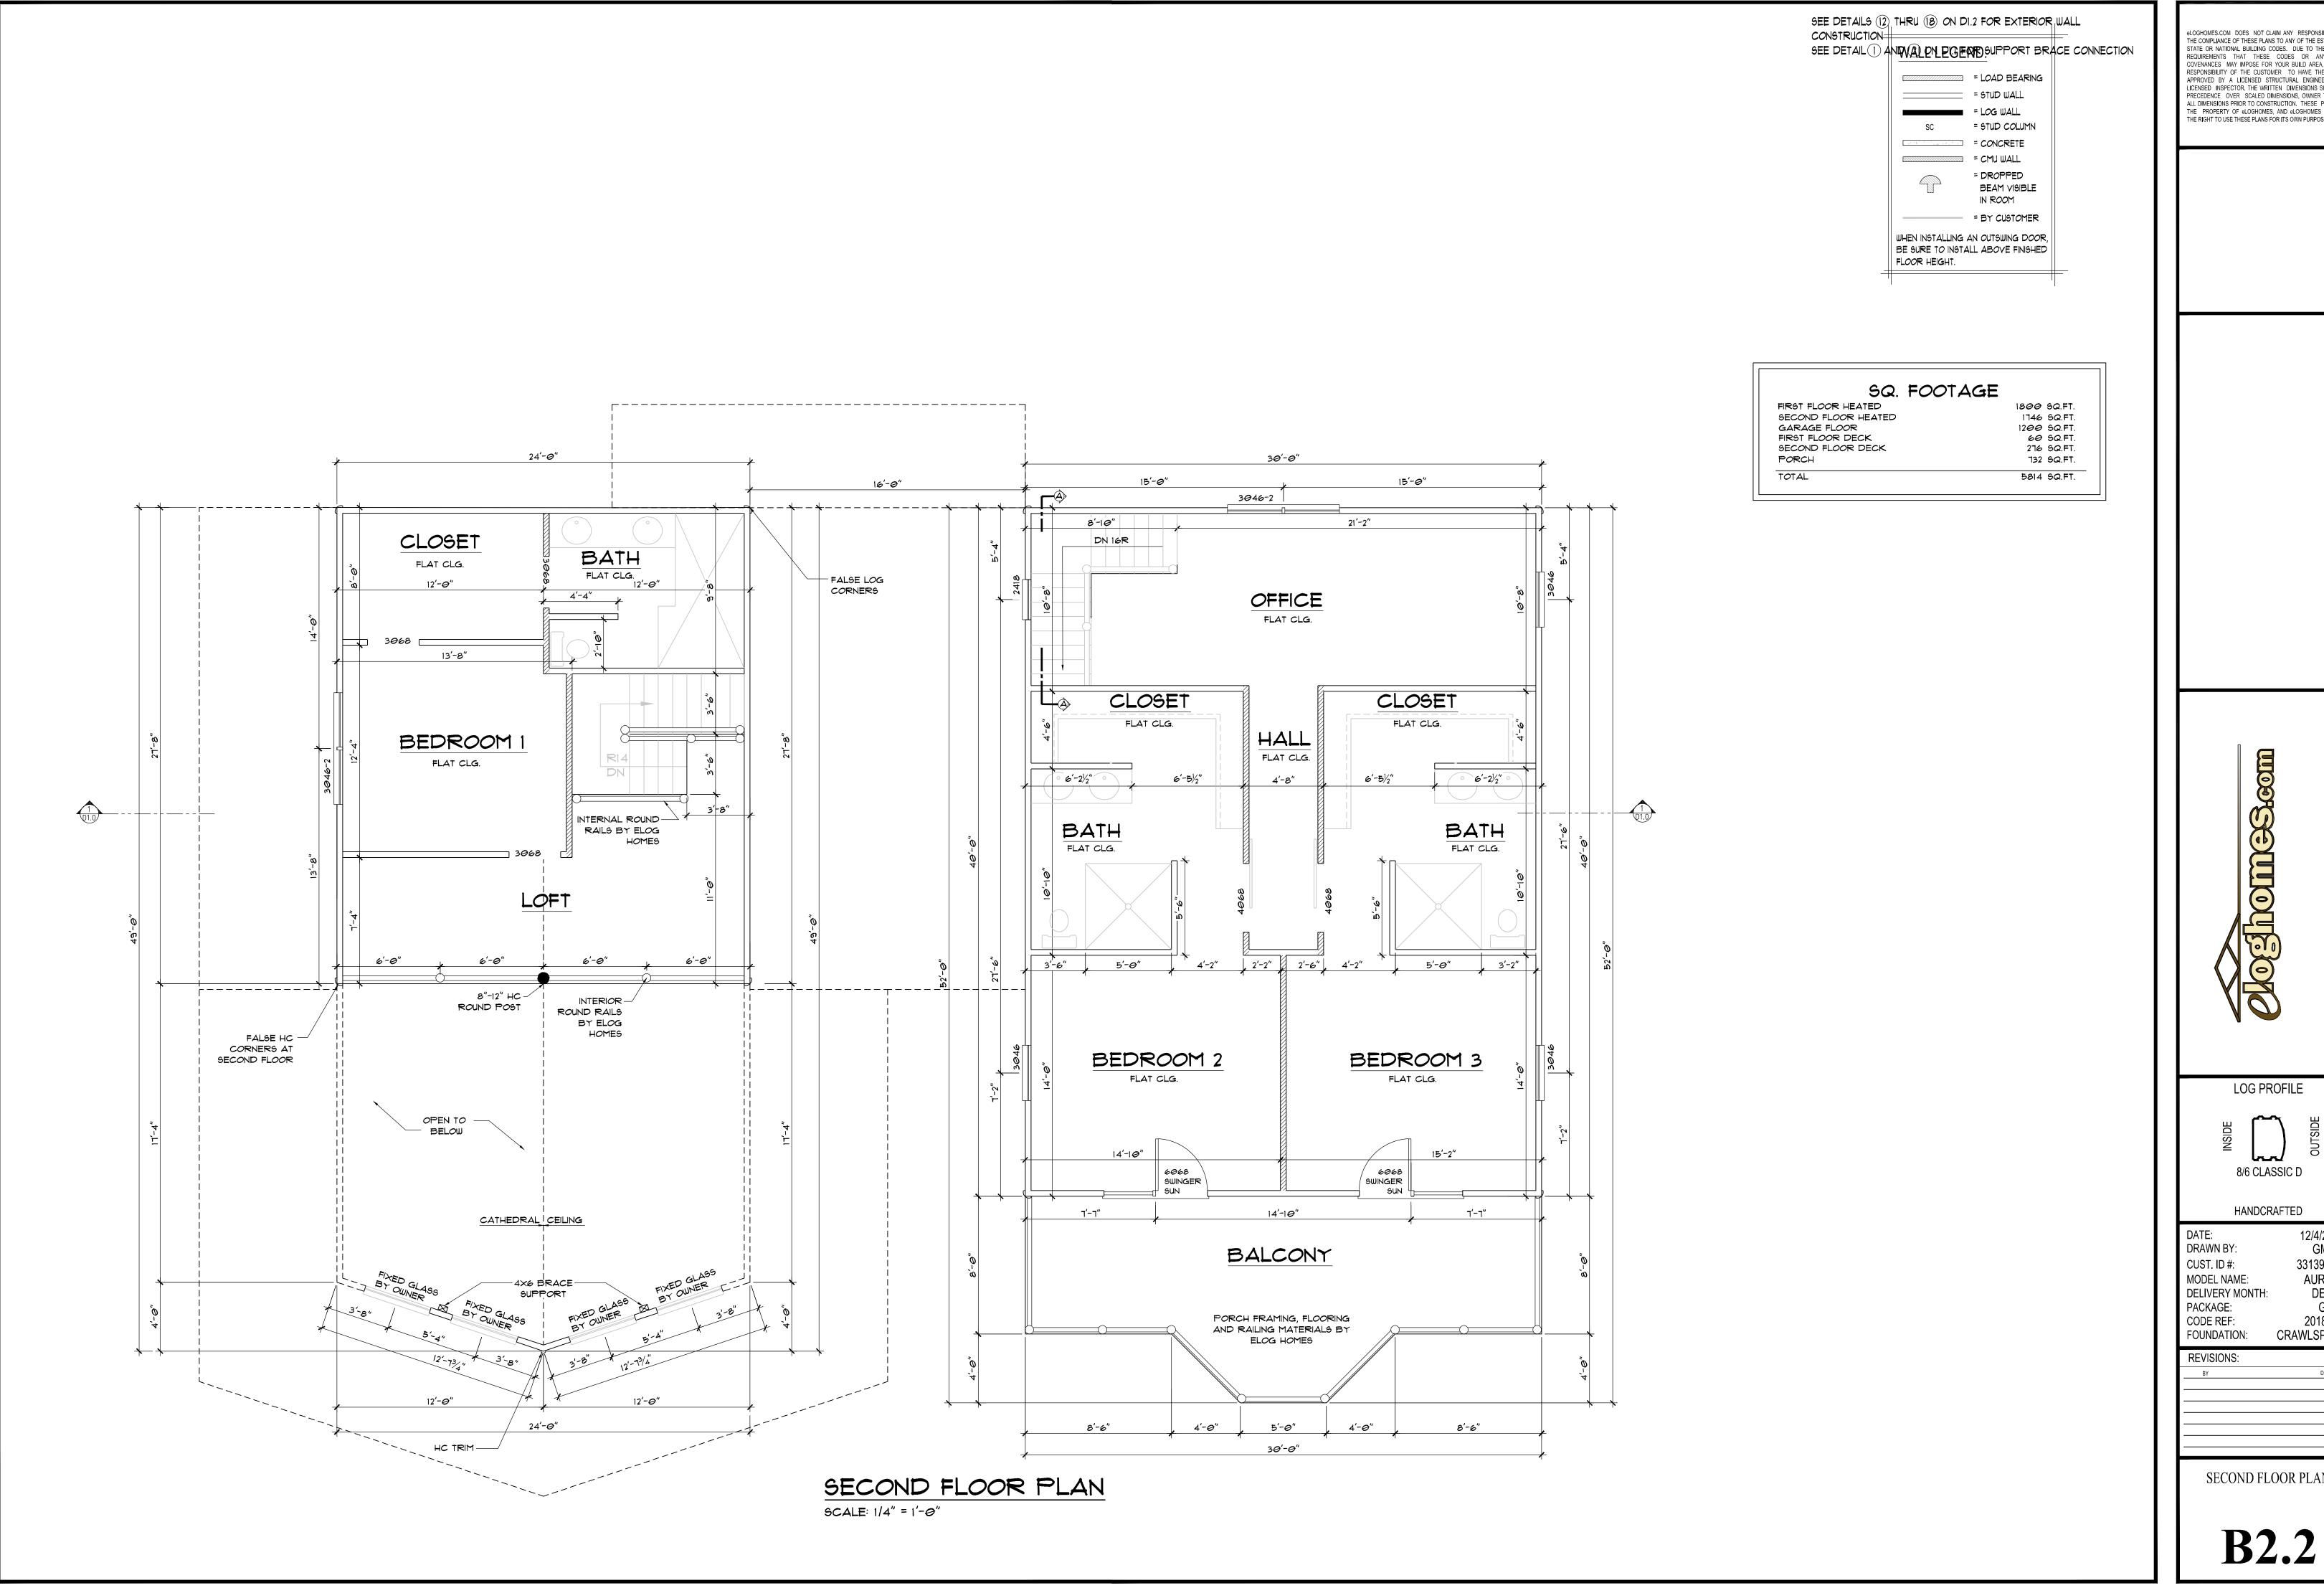
DELIVERY MONTH:

PACKAGE:

CODE REF:

FOUNDATION: REVISIONS: **ELEVATIONS B1.3**






eLOGHOMES.COM DOES NOT CLAIM ANY RESPONSIBILITY FOR THE COMPLIANCE OF THESE PLANS TO ANY OF THE ESTABLISHED STATE OR NATIONAL BUILDING CODES. DUE TO THE SPECIFIC REQUIREMENTS THAT THESE CODES OR ANY OTHER COVENANCES MAY IMPOSE FOR YOUR BUILD AREA, IT IS THE RESPONSIBILITY OF THE CUSTOMER TO HAVE THESE PLANS APPROVED BY A LICENSED STRUCTURAL ENGINEER AND A LICENSED INSPECTOR. THE WRITTEN DIMENSIONS SHALL HAVE PRECEDENCE OVER SCALED DIMENSIONS, OWNER TO VERIFY ALL DIMENSIONS PRIOR TO CONSTRUCTION. THESE PLANS ARE THE PROPERTY OF eLOGHOMES, AND eLOGHOMES RESERVES THE RIGHT TO USE THESE PLANS FOR ITS OWN PURPOSE.

LOG PROFILE


12/4/2024 GM/AM 331390751
AURORA
DEC 24
GOLD
2018 IRC
CRAWLSPACE

SECOND FLOOR PLAN

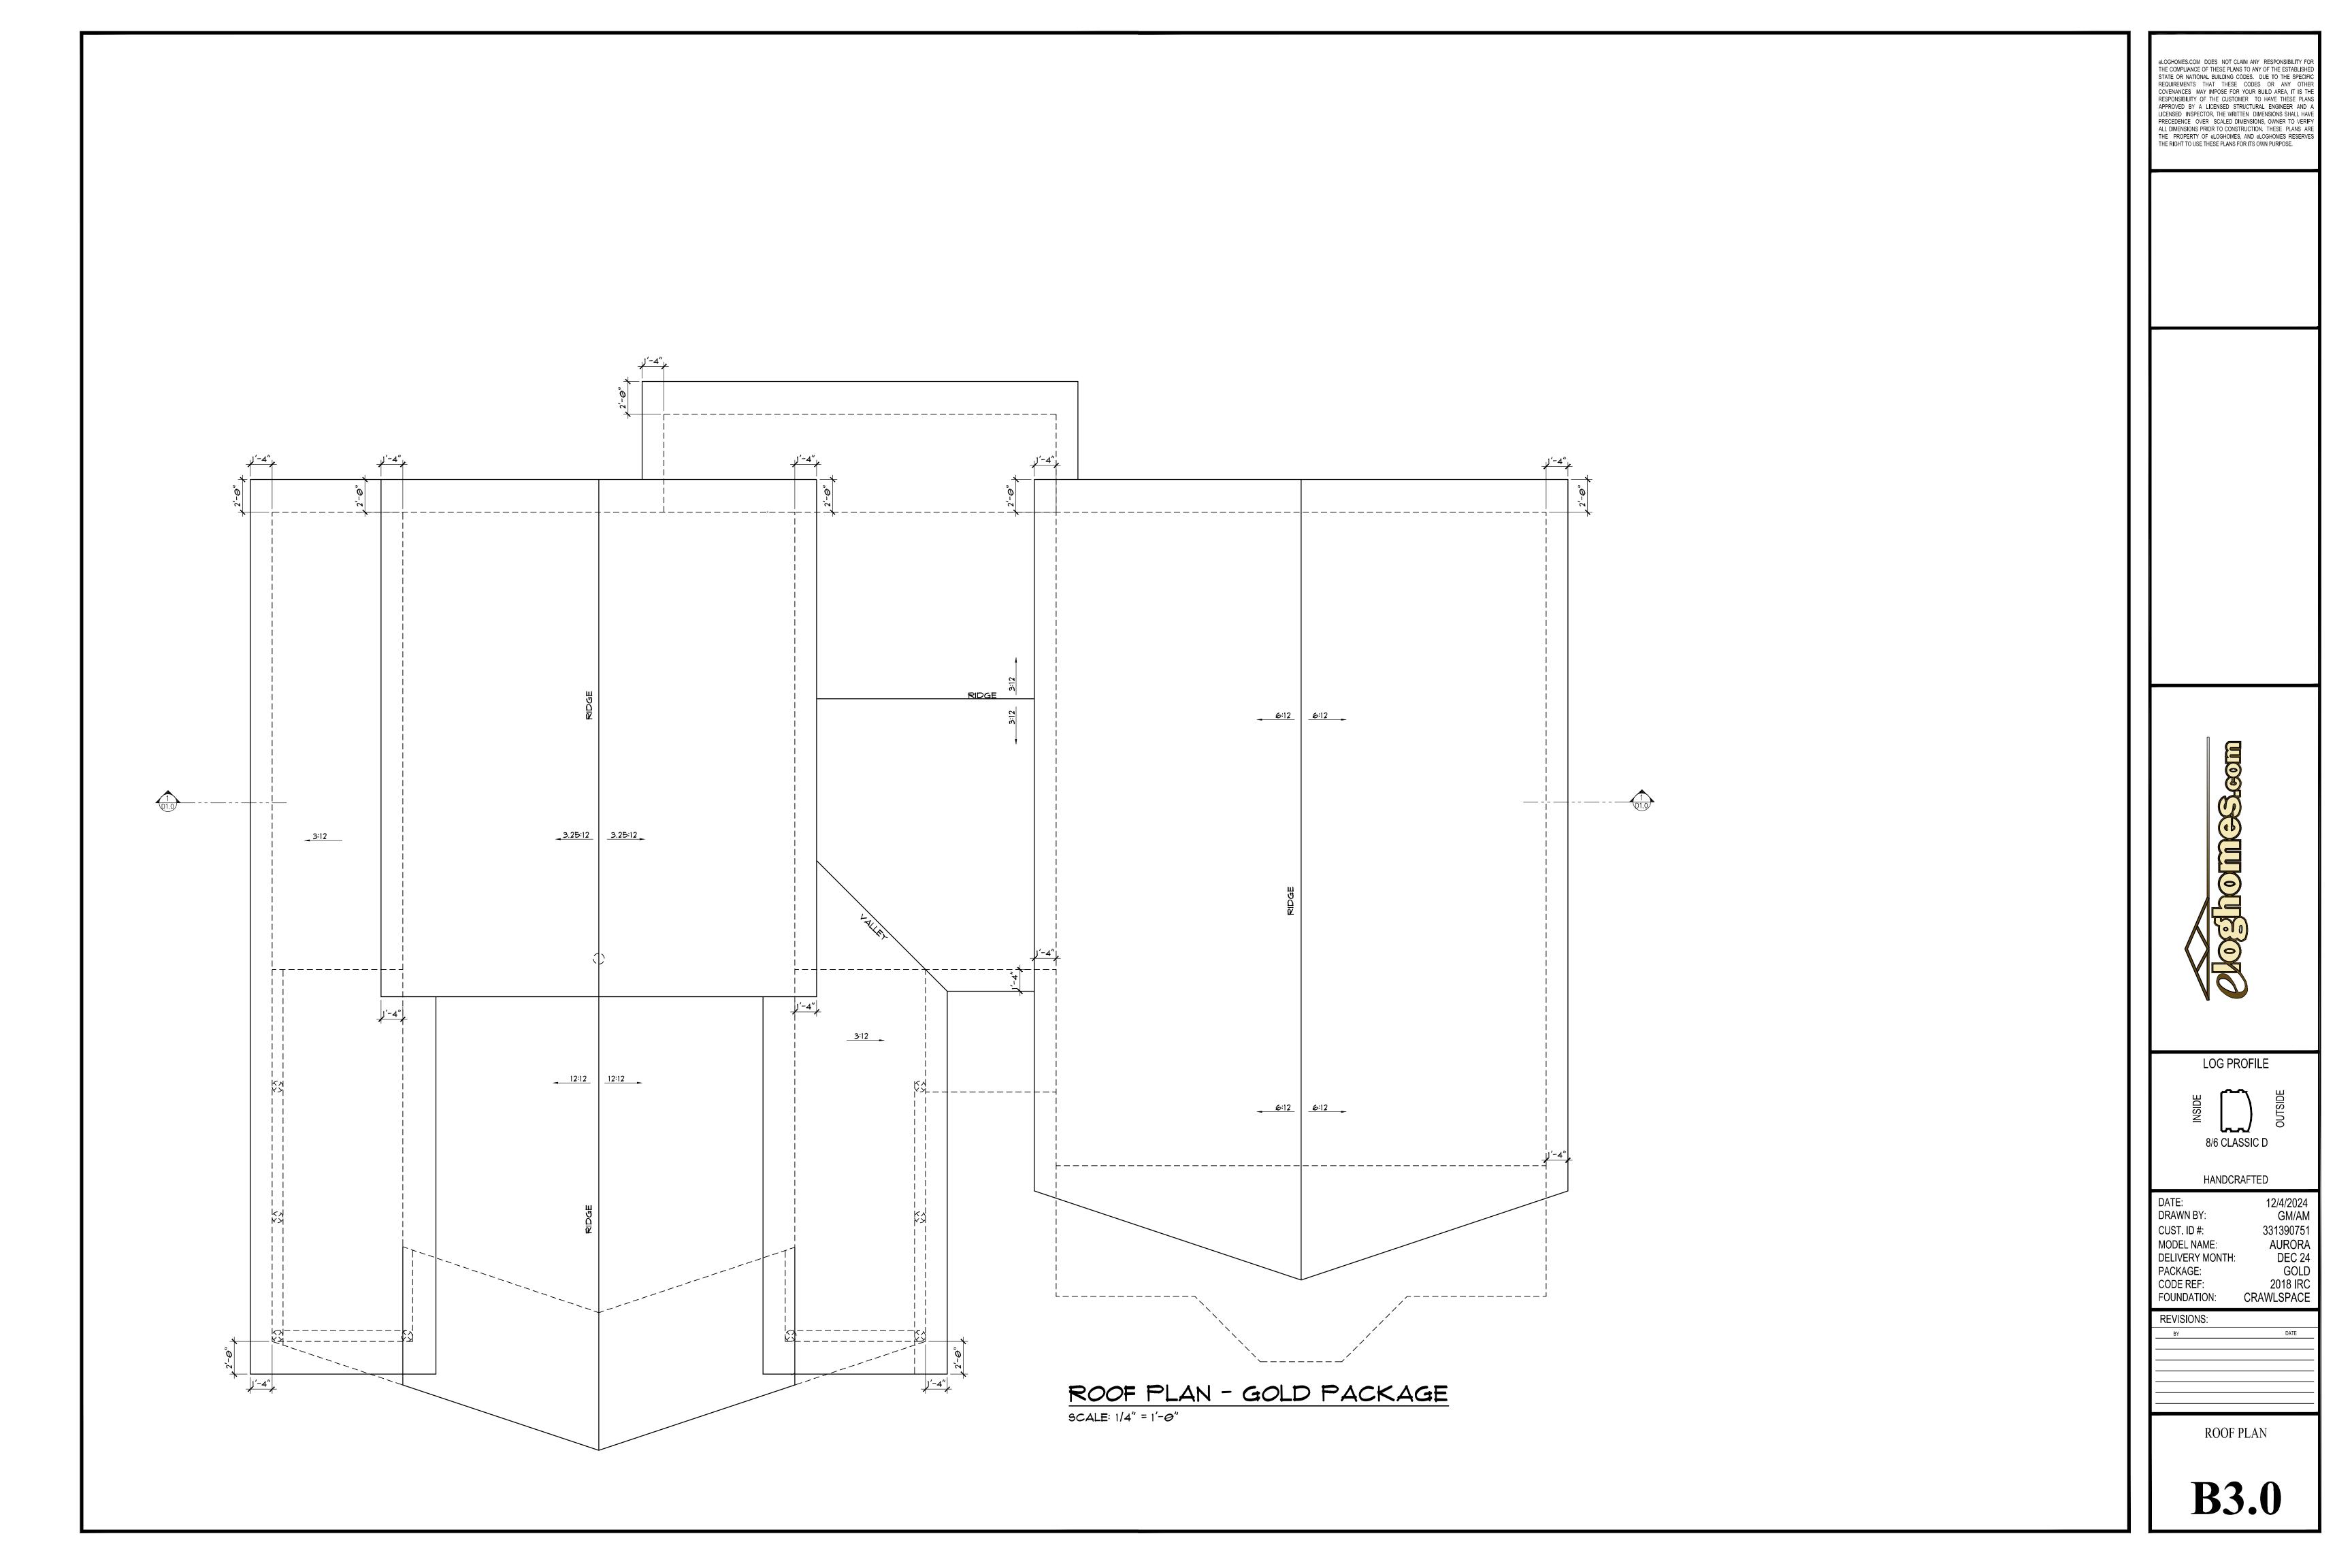

THIS SUPPORT LAYOUT HAS NOT BEEN REVIEWED BY A LICENSED STRUCTURAL ENGINEER. CUSTOMER IS RESPONSIBLE FOR OBTAINING SEALED FOUNDATION SHEET. THIS DRAWING IS NOT TO BE USED FOR CONSTRUCTION. FOOTING SIZES AND LOCATIONS, REINFORCING STEEL SIZES, DIMENSIONS AND LOCATIONS ARE TO BE VERIFIED BY STRUCTURAL ENGINEER. HOME OWNER ASSUMES ALL LIABILITY FOR FOUNDATION DESIGN. 24'-*0"* 7'-11³/₄" 7'-8" 8'-4" GIRDER SUPPORT - FOUNDATION PERIMETER **GIRDER SUPPORT** REQUIRED. **DESIGNED BY OTHERS** REQUIRED. **BEAM POCKET OR** BEAM POCKET OR PILASTER PIER. PILASTER PIER. — GARAGE 11'-9³/₄" 8'-21/4" 7'-101/4" 8'-21/4" GIRDER SUPPORT REQUIRED. GIRDER SUPPORT REQUIRED. BEAM POCKET OR BEAM POCKET OR PILASTER PIER. 10'-2" 9'-8" 1*0*'-2" PILASTER PIER. 8'-0" CONCRETE SLAB BY OTHERS FOUNDATION PERIMETER DESIGNED BY OTHERS FOUNDATION PERIMETER **DESIGNED BY OTHERS** GIRDER SUPPORT -REQUIRED. BEAM POCKET OR PILASTER PIER. HC POSTS POST SUPPORT DESIGNED BY OTHERS REQUIRED SUPPORT LOCATION.
 SIZE OF POST AND FOOTING DECK PERIMETER 10'-2" DETERMINED BY E.O.R. TYP. **REVISIONS**: 3*0'-0"* 6'-11³/₄" 4'-91/4" 6'-61/2" 4'-91/4" REQUIRED SUPPORT LAYOUT PLAN 40'-0" SCALE: 1/4" = 1'-0"

eLOGHOMES.COM DOES NOT CLAIM ANY RESPONSIBILITY FOR THE COMPLIANCE OF THESE PLANS TO ANY OF THE ESTABLISHED STATE OR NATIONAL BUILDING CODES. DUE TO THE SPECIFIC REQUIREMENTS THAT THESE CODES OR ANY OTHER COVENANCES MAY IMPOSE FOR YOUR BUILD AREA, IT IS THE RESPONSIBILITY OF THE CUSTOMER TO HAVE THESE PLANS APPROVED BY A LICENSED STRUCTURAL ENGINEER AND A APPROVED BY A LICENSED STRUCTURAL ENGINEER AND A LICENSED INSPECTOR. THE WRITTEN DIMENSIONS SHALL HAVE PRECEDENCE OVER SCALED DIMENSIONS, OWNER TO VERIFY ALL DIMENSIONS PRIOR TO CONSTRUCTION. THESE PLANS ARE THE PROPERTY OF eLOGHOMES, AND eLOGHOMES RESERVES THE RIGHT TO USE THESE PLANS FOR ITS OWN PURPOSE.

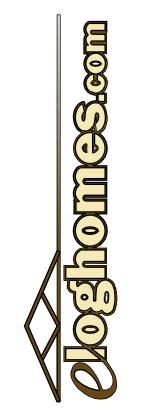

LOG PROFILE

HANDCRAFTED

12/4/2024 GM/AM DRAWN BY: CUST. ID #: 331390751 MODEL NAME: AURORA DEC 24 GOLD DELIVERY MONTH: PACKAGE: CODE REF: FOUNDATION: 2018 IRC CRAWLSPACE

SUPPORT LAYOUT